


## BUILDING KEY

① DAIRY	OLD KINDERGARTEN SCHOOL	MSS - PRIMARY SCHOOL BLOCK EXTENSION
SWIMMING POOL	D CARPENTRY (TO BE DEMOLISHED)	MSS - LEARNING RESOURCE CENTRE
③ GUEST HOUSE + KULLA 1	13 RESIDENTIAL AREA	3 MSS - SECONDARY SCHOOL BLOCK
④ KITCHEN/DINING/LAUNDRY	1 BIG BOYS HOSTEL	4 MSS - KINDERGARTEN
5 BIG GIRLS HOSTEL	<b>19</b> VEHICLE STORAGE (TO BE DEMOLISHED)	5 MSS - AUDITORIUM/GYMNASIUM
⑥ NEW GIRLS HOSTEL	16 KULLA 2	6 MSS - CENTRAL ASSEMBLY AREA
⑦ SMALL GIRLS HOSTEL	1 WORKSHOP AREA	7 MSS - PLAY-FIELD
⑧ NURSERY	19 MAXTON STRONG SCHOOL(MSS)	8 STAFF HOUSING
IRECTOR'S RESIDENCE	- PRIMARY SCHOOL BLOCK	9 OFFICE
1 SMALL BOYS HOSTEL	EXISTING BUILDINGS	10 GUEST HOUSE
	# PROPOSED BUILDINGS	11 FAMILY PAVILION + PLAY AREA




LEGEND	
PROPERTY CORNER	¢
BOUNDARY LINE	
WALL	
EXISTING UTILITY POLE	۲
OVERHEAD ELECTRICAL LINE	
T-FENCEPOSTS, PRESUMED UNMAINTAINED FENCE LINE	x x x
EXISTING TREE	Ĉ.,
PROPOSED TREE	8
EXISTING BUILDINGS	
PROPOSED BUILDINGS	
EXISTING BUILDINGS TO BE DEMOLISHED	
EXISTING/PROPOSED ROADS	

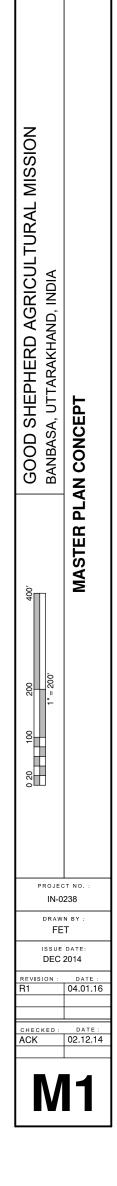


$\bigcirc$	MASTER PLAN CONCEPT	
U	1" = 200'	SITE AREA: 74.02 ACRES



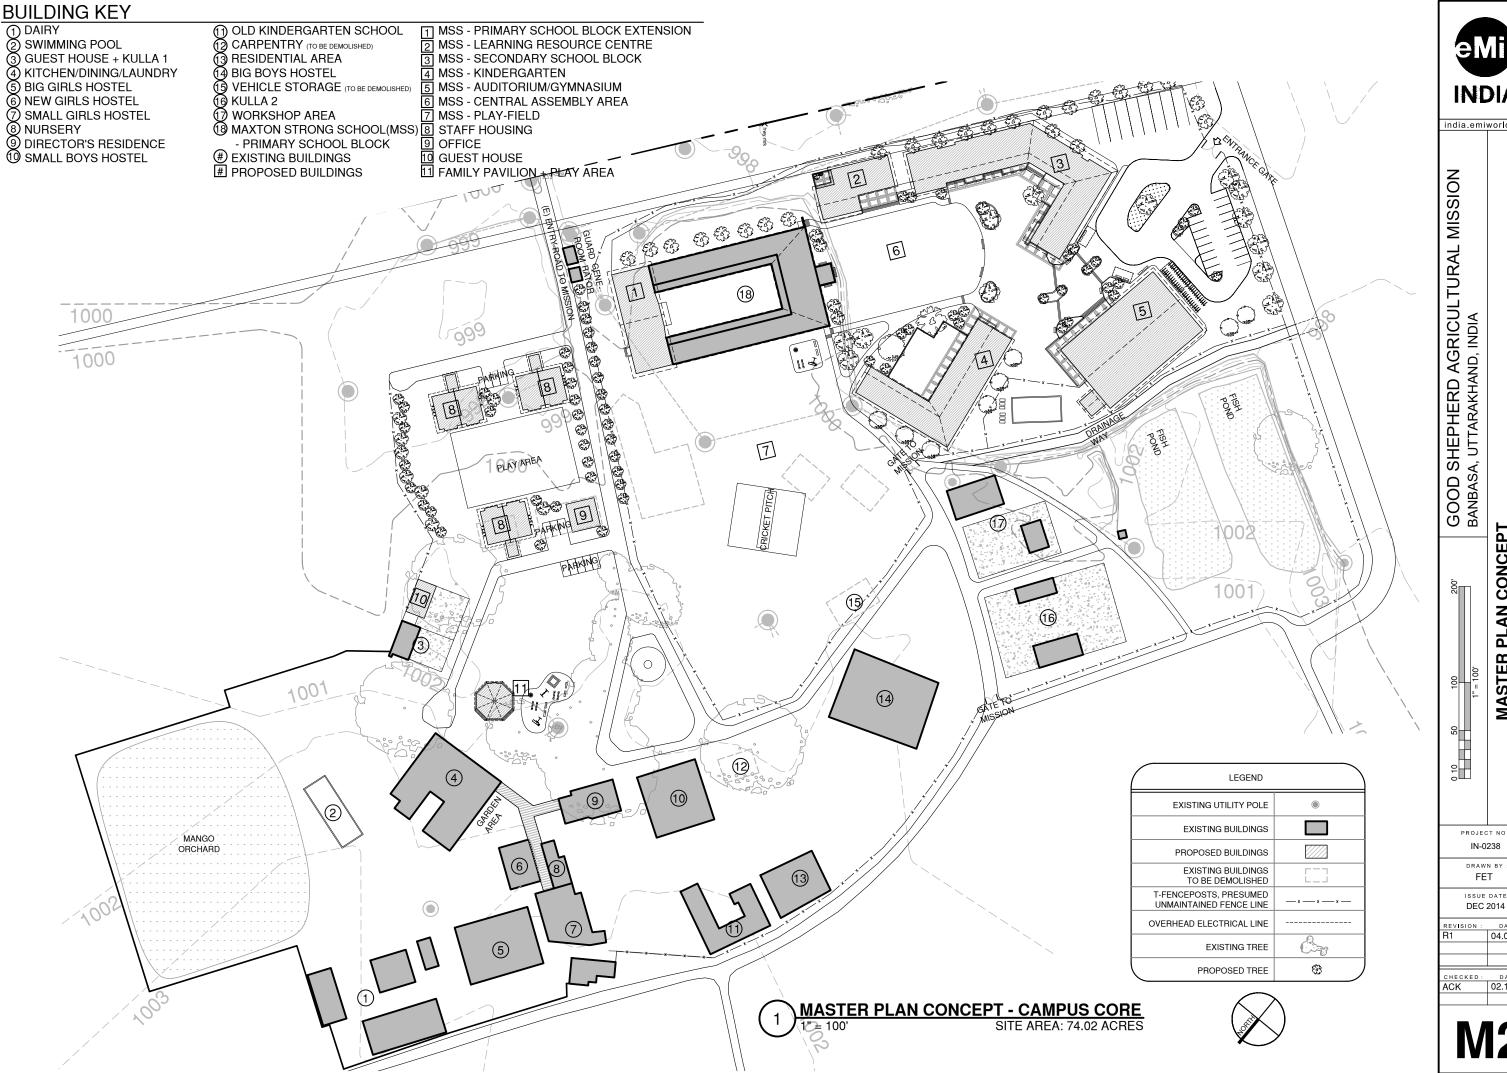

**INDIA** india.emiworld.org GOOD SHEPHERD AGRICULTURAL MISSION BANBASA, UTTARAKHAND, INDIA MASTER PLAN CONCEPT CAMPUS CORE PROJECT NO. IN-0238 DRAWN BY FET ISSUE DATE: DEC 2014 REVISION : DATE : 04.01.16 DATE: 02.12.14 HECKED :

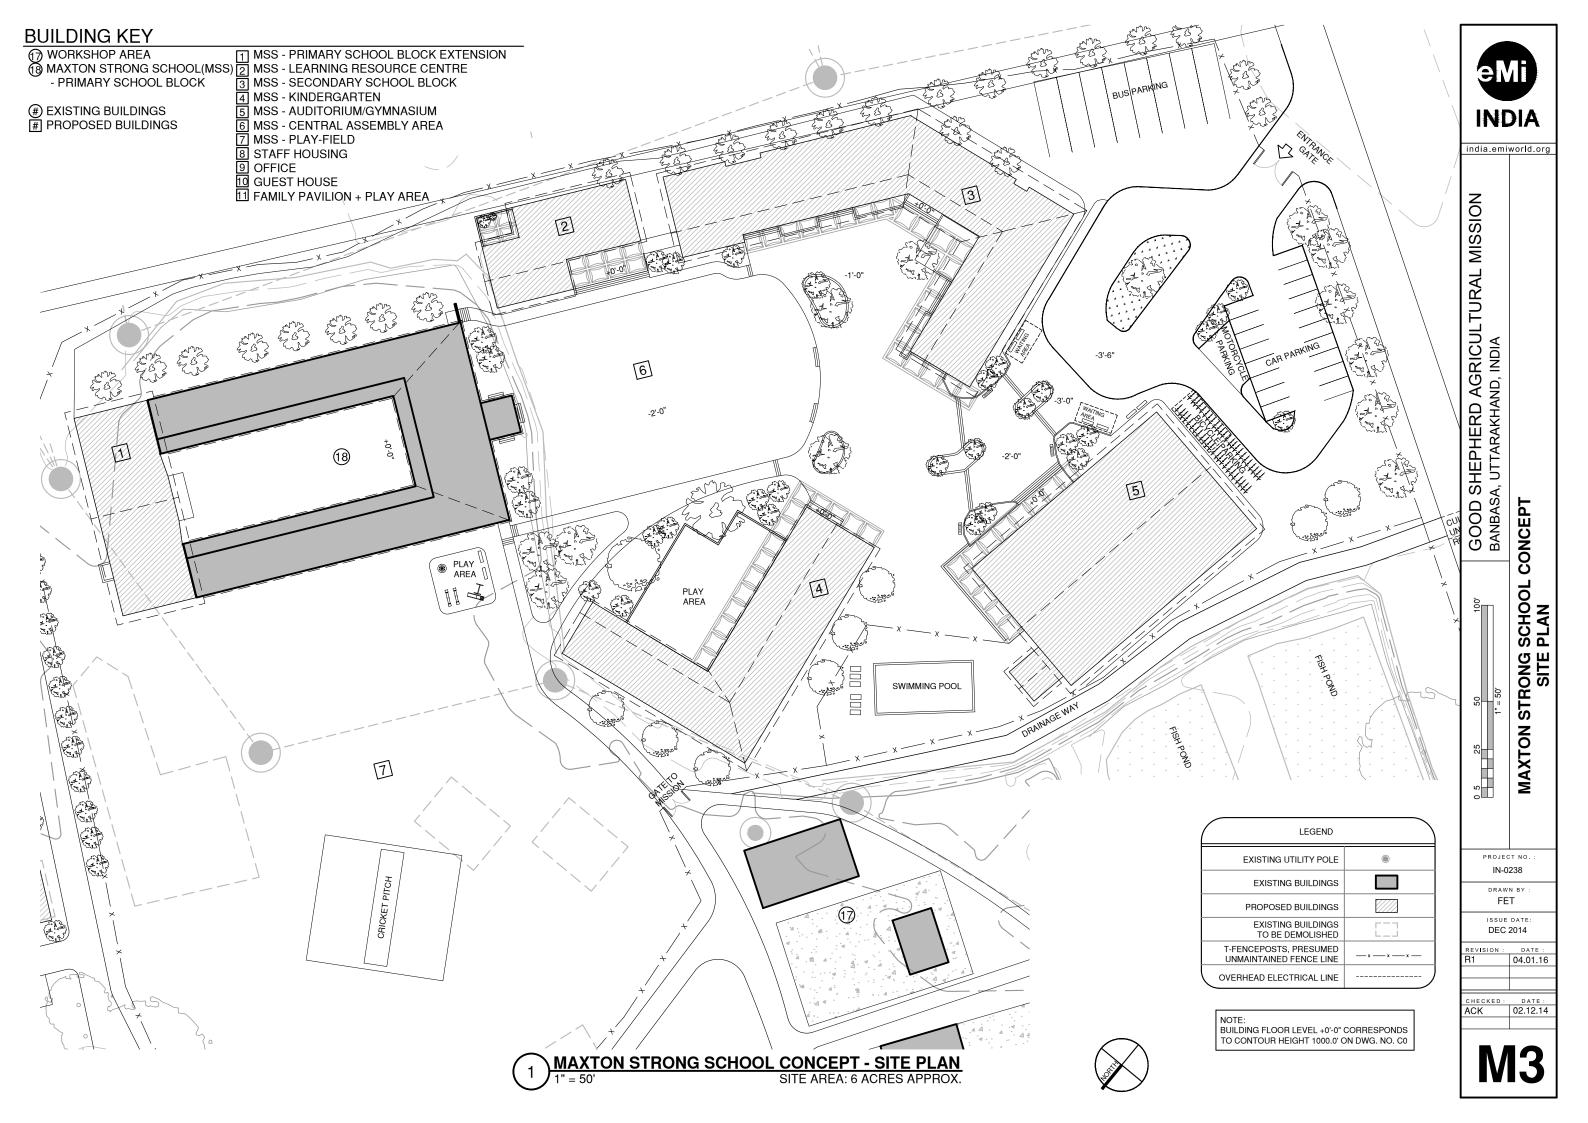




MAXTON STRONG SCHOOL - SECONDARY SCHOOL CONCEPT - PERSPECTIVE




GOOD SHEPHERD AGRICULTURAL MISSION BANBASA, UTTARAKHAND, INDIA	MAXTON STRONG SCHOOL - SECONDARY SCHOOL CONCEPT PERSPECTIVE
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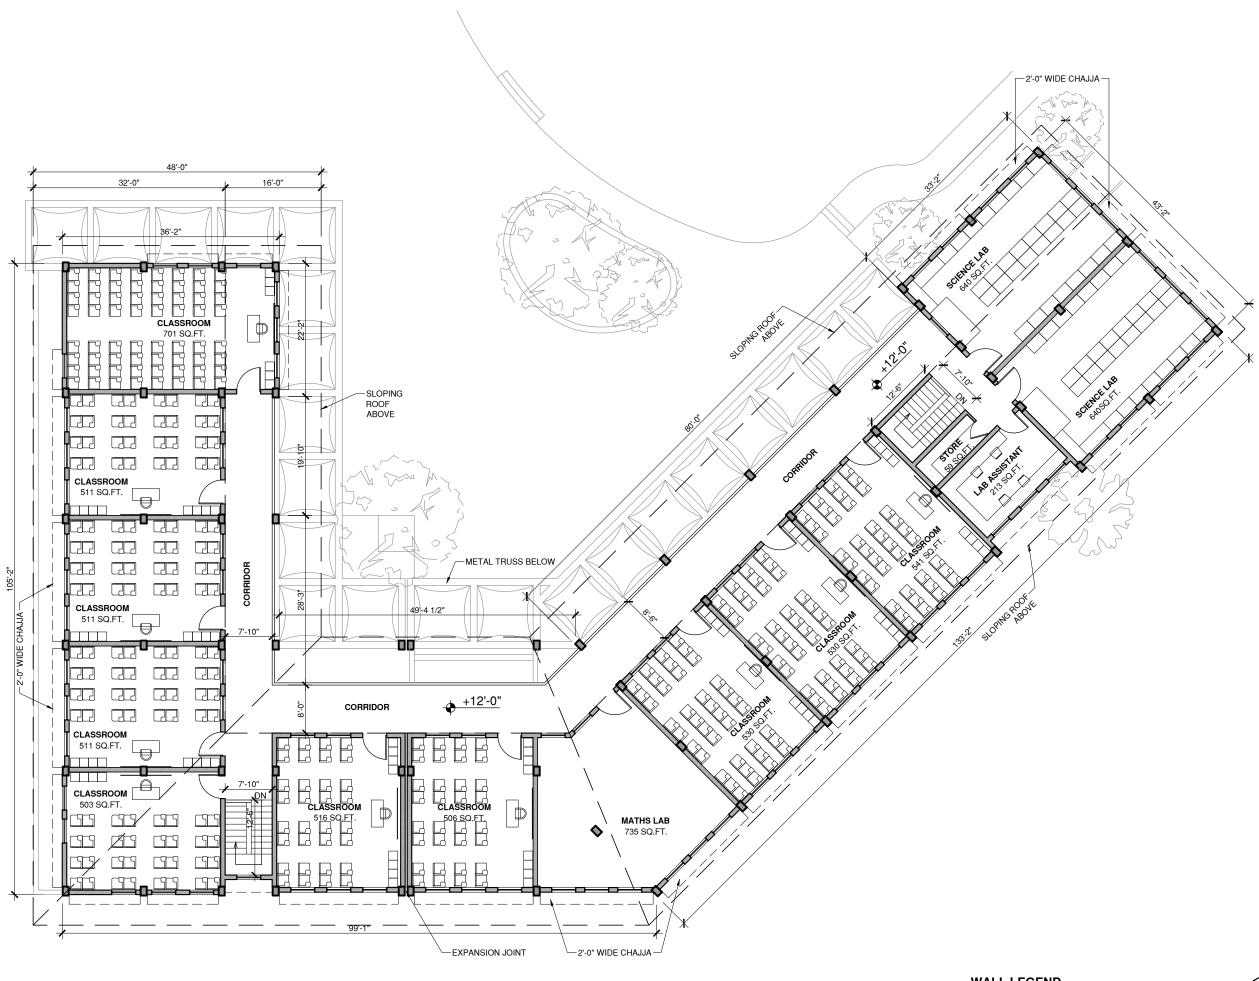


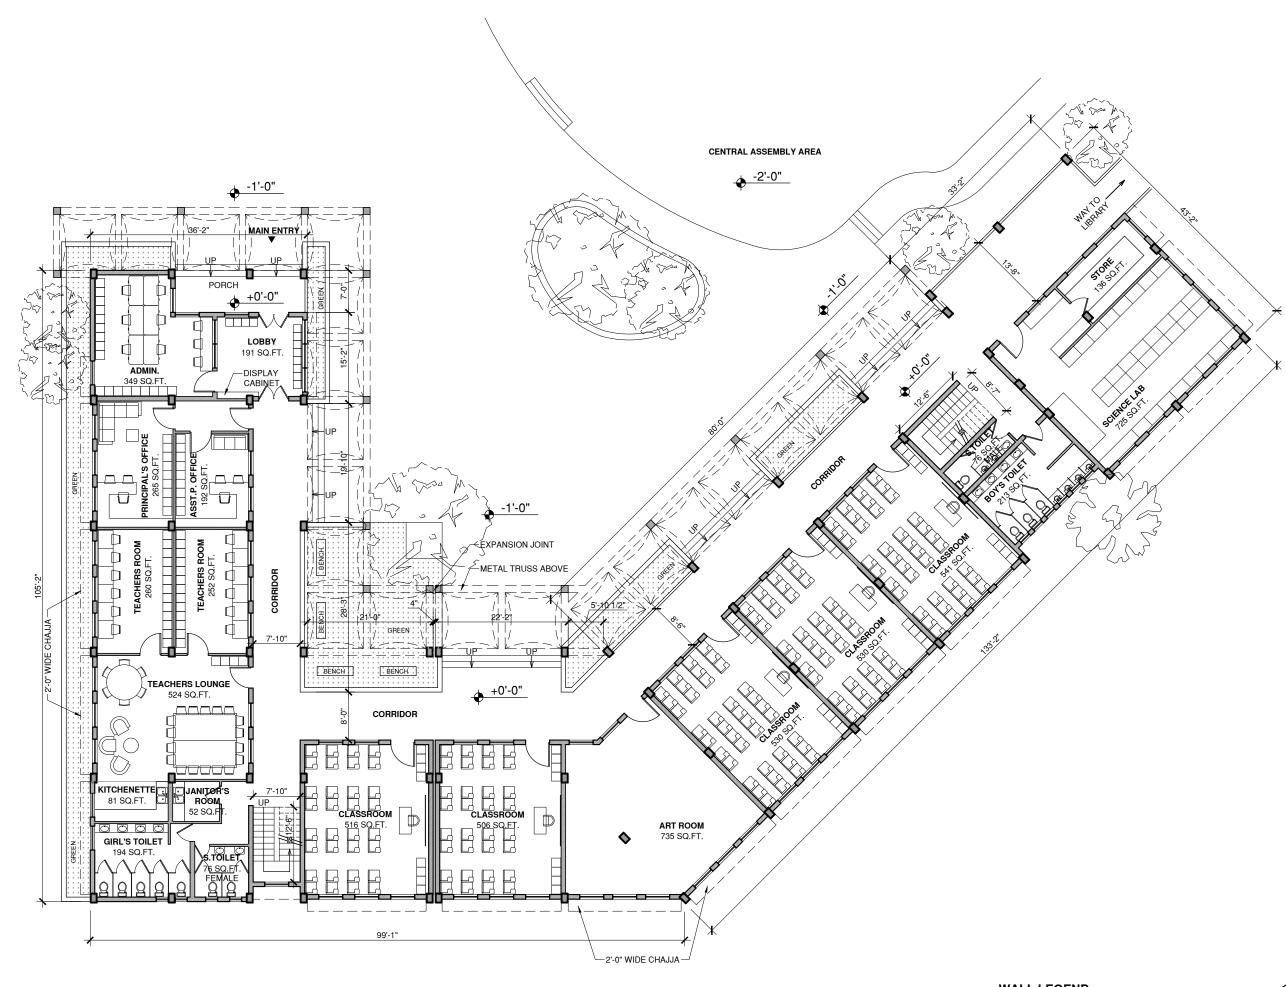

WALL LEGEND

EXTERIOR WALL WITH 10in DOUBLE BRICK CAVITY WALL INTERIOR WALL WITH 5in SINGLE BRICK & PLASTER E LOW / PARTIAL HEIGHT WALL




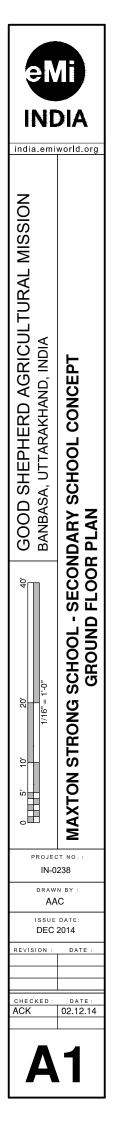





E LOW / PARTIAL HEIGHT WALL

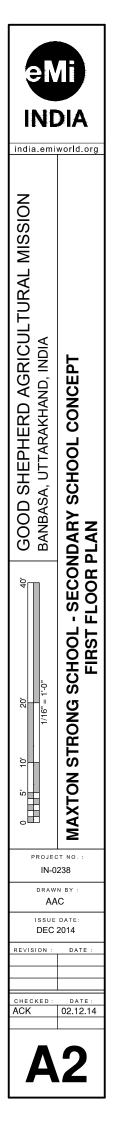




EXTERIOR WALL WITH 10in DOUBLE BRICK CAVITY WALL INTERIOR WALL WITH 5in SINGLE BRICK & PLASTER



# MAXTON STRONG SCHOOL - LEARNING RESOURCE CENTRE CONCEPT - PERSPECTIVE



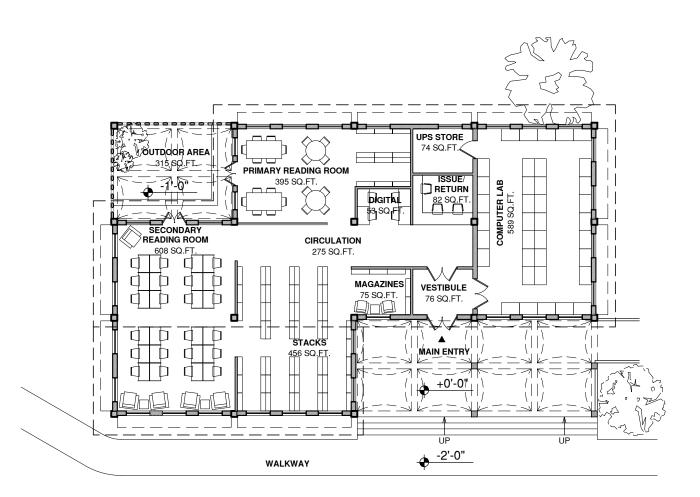







EXTERIOR WALL WITH 9in DOUBLE BRICK WALL


INTERIOR WALL WITH 4.5in SINGLE BRICK WALL

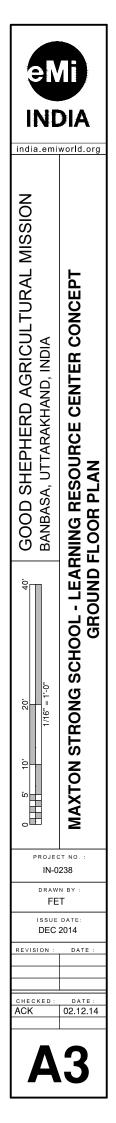



### MAXTON STRONG SCHOOL - KINDERGARTEN CONCEPT - PERSPECTIVE

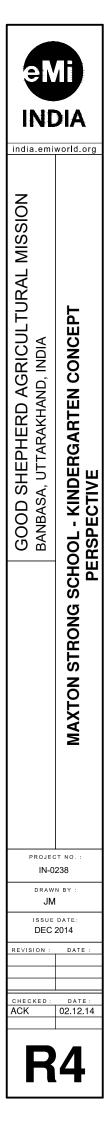


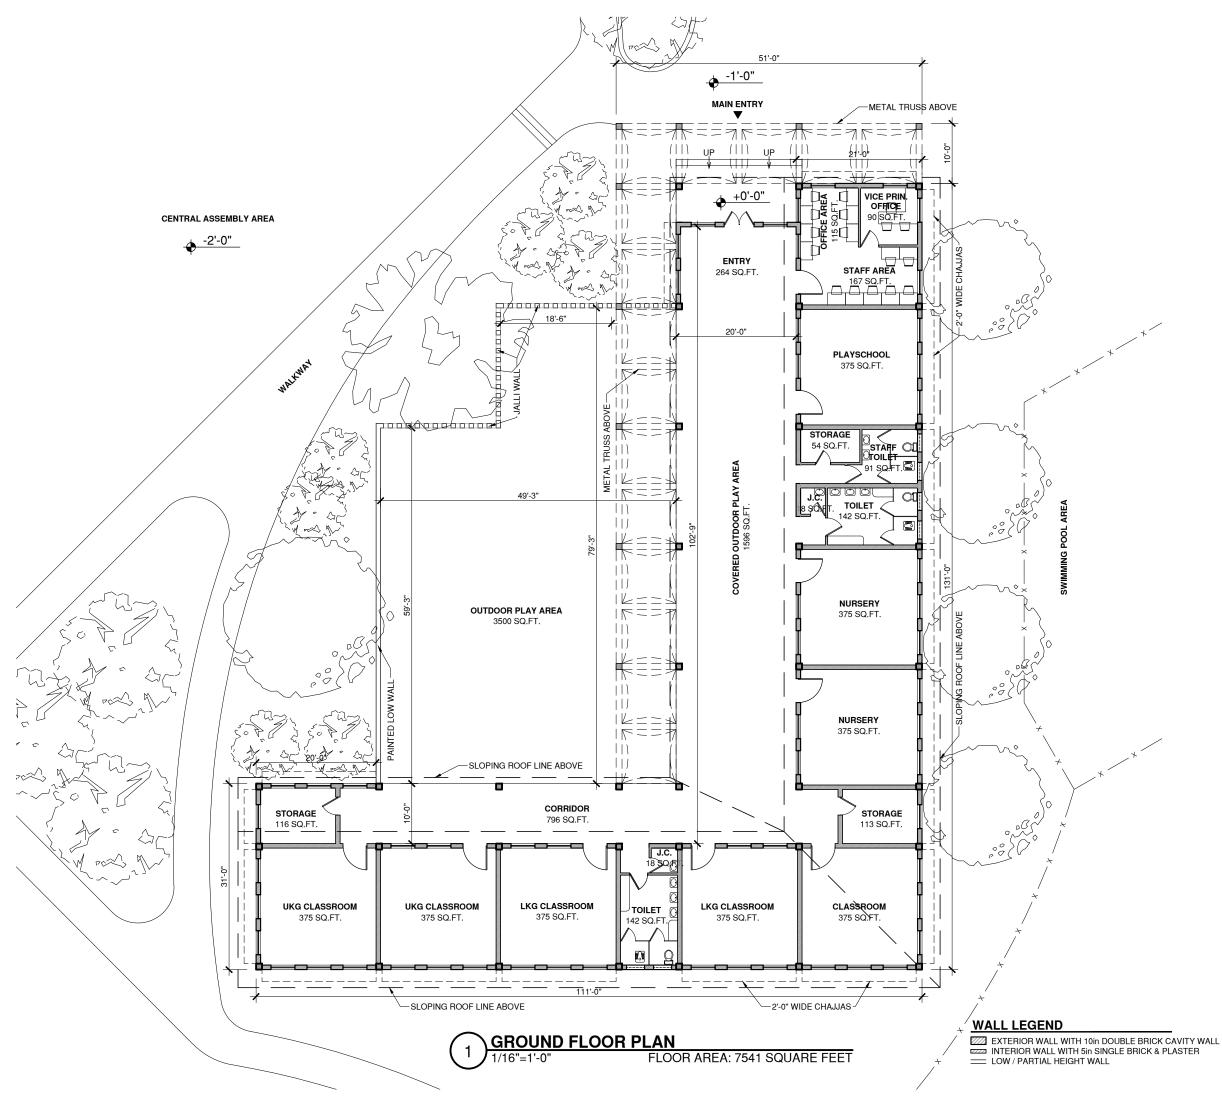

	DIA
0     5     10     20'     40'       HILL     1/16' = 1:0'     BANBASA, UTTARAKHAND, INDIA	MAXTON STRONG SCHOOL - KINDERGARTEN CONCEPT GROUND FLOOR PLAN
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#### NOTES:

- TOPOGRAPHIC SURVEY WAS PERFORMED FOR THE PURPOSE OF PREPARING A MASTER PLAN. DETAIL OF THE FEATURES SURVEYED MEETS THE REQUIREMENTS FOR THIS PURPOSE. ELEVATIONS WERE MEASURED TO OBTAIN A GENERAL IDEA OF THE TERRAIN OF THE PROPERTY TO PREPARE THE MASTER PLAN.
- 2. ALL FEATURES LOCATED OUTSIDE OF THE PROPERTY BOUNDARY WERE LOCATED USING LOW RESOLUTION UN-RECTIFIED AERIAL IMAGES, AND THEIR LOCATION AS SHOWN ON THIS SURVEY IS APPROXIMATE IN NATURE. THESE FEATURES WERE NOT LOCATED AS PART OF THE ON-SITE SURVEY AND ARE NOT INTENDED TO REPRESENT SURVEYED FEATURES.
- 3. CONTOUR INTERVAL IS 0.3 FEET.
- 4. AREA OF THE SURVEYED PARCEL IS APPROXIMATELY 29.96 HECTARES (74.02 ACRES).
- 5. MEASUREMENTS ARE IN FEET.

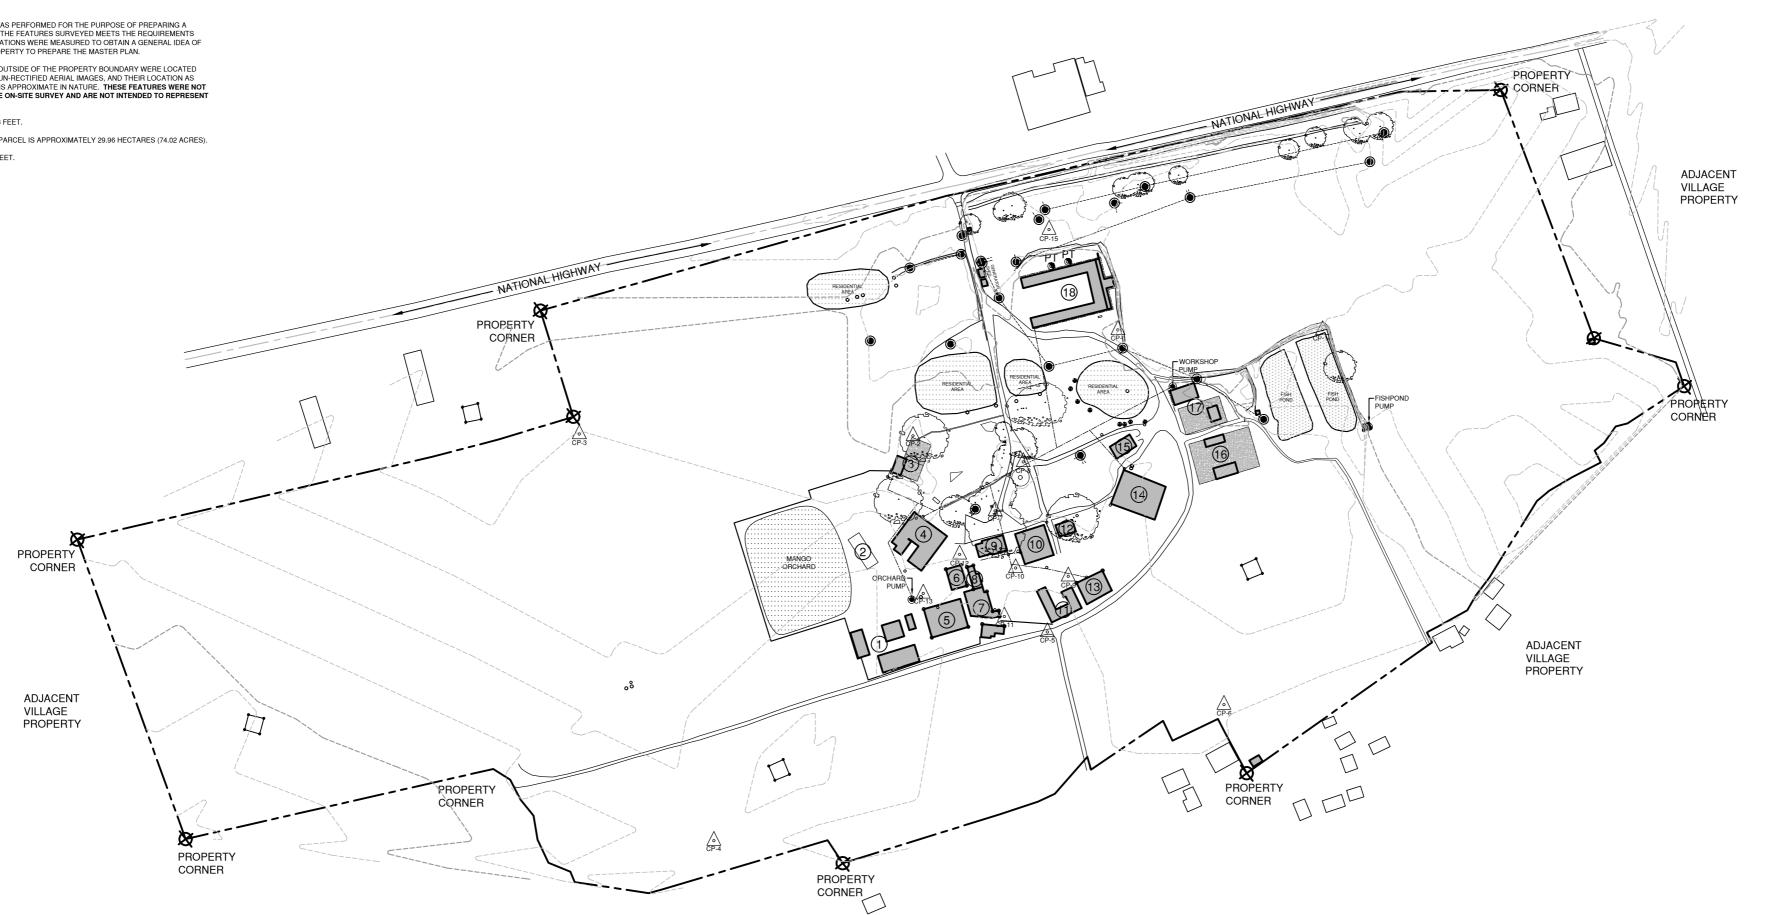

#### HORIZONTAL CONTROL POINTS:

POINT	NORTHING	EASTING	ELEVATION	DESCRIPTION
1	10000.00	20000.00	1000.00	2.5 INCH NAIL
2	9714.85	20005.88	999.77	2.5 INCH NAIL
3	8878.23	20217.05	1001.02	2.5 INCH NAIL
4	9158.45	21063.84	1003.68	2.5 INCH NAIL
5	9853.07	20629.22	1002.66	2.5 INCH NAIL
6	10220.79	20780.57	1001.82	2.5 INCH NAIL
7	10426.05	19999.89	1002.67	2.5 INCH NAIL
8	9802.74	20274.89	1001.59	2.5 INCH NAIL
9	9896.50	20513.35	1001.68	2.5 INCH NAIL
10	9786.78	20495.95	1001.67	2.5 INCH NAIL
11	9763.63	20597.16	1002.34	CONC. MARK
12	9760.23	20467.68	1001.67	2.5 INCH NAIL
13	9594.44	20548.91	1001.95	CONC. MARK
14	10426.01	20000.00	1002.49	2.5 INCH NAIL
15	9856.44	19791.07	998.43	2.5 INCH NAIL

### BASIS OF DIRECTIONS:


DIRECTIONS ARE MAGNETIC BASED UPON A COMPASS READING BETWEEN CONTROL POINTS.

### SURVEY EQUIPMENT & DATE:

SITE WAS SURVEYED SEPTEMBER 9 - 13, 2014. A TOPCON GPT-3005 TOTAL STATION WAS USED TO COLLECT SITE INFORMATION.

- BUILDING KEY

  1 DAIRY
  2 SWIMMING POOL
  3 GUEST HOUSE + KULLA 1
  4 KITCHEN/DINING/LAUNDRY
  C BIG GIPLS HOSTEL
- 5 BIG GIRLS HOSTEL
- 6 NEW GIRLS HOSTEL 7 SMALL GIRLS HOSTEL
- **INURSERY**
- **(9)** DIRECTOR'S RESIDENCE
- **1** SMALL BOYS HOSTEL
- 1) OLD KINDERGARTEN SCHOOL 12 CARPENTRY (TO BE DEMOLISHED)
- RESIDENTIAL AREA
   BIG BOYS HOSTEL
- UEHICLE STORAGE (TO BE DEMOLISHED) 🔞 KULLA 2
- WORKSHOP AREA MAXTON STRONG SCHOOL(MSS)
- PRIMARY SCHOOL BLOCK

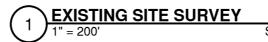

_		
(	LEGEND	
	PROPERTY CORNER	
Р	ERCOLATION TEST HOLE	PT
HORI	ZONTAL CONTROL POINT	CP1 🛆
	BOUNDARY LINE	
	EXISTING UTILITY POLE	۲
	EXISTING TREE	0
	EXISTING STRUCTURE	
	EXISTING ROAD	
	WALL	
OVE	RHEAD ELECTRICAL LINE	
	RESIDENTIAL AREA (NOT SURVEYED)	




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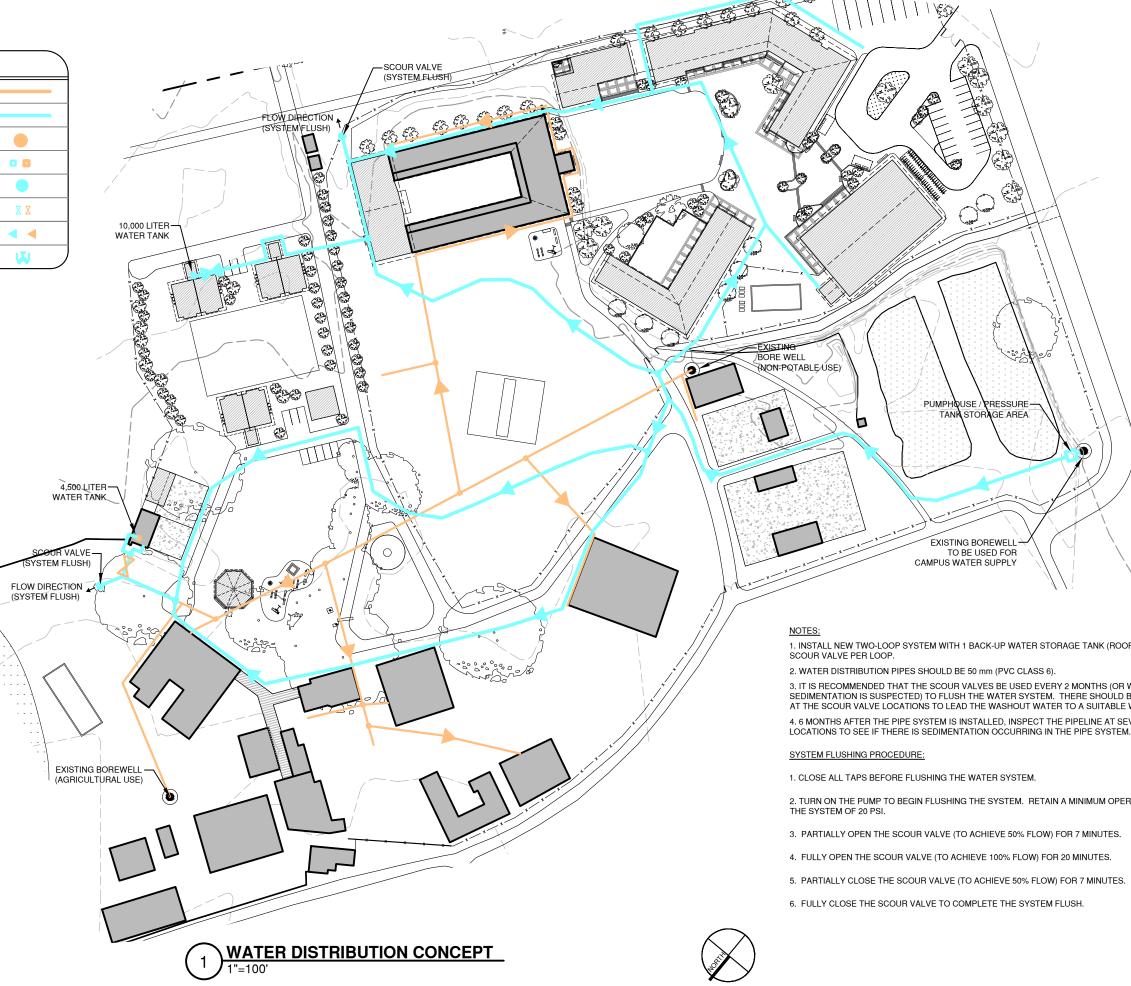
INDIA


india.emiworld.org



SITE AREA: 74.02 ACRES



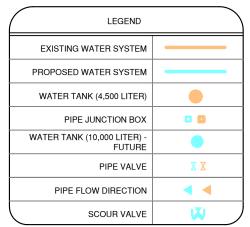


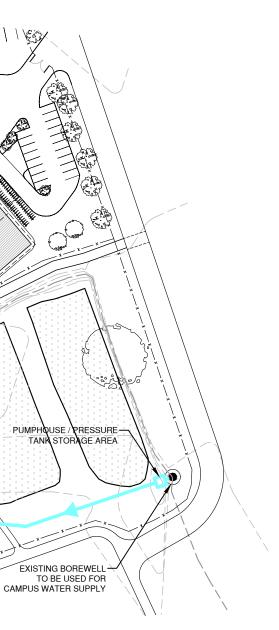


1. INSTALL NEW TWO-LOOP SYSTEM WITH 1 BACK-UP WATER STORAGE TANK (ROOF LEVEL) AND 1

3. IT IS RECOMMENDED THAT THE SCOUR VALVES BE USED EVERY 2 MONTHS (OR WHEN ANY SEDIMENTATION IS SUSPECTED) TO FLUSH THE WATER SYSTEM. THERE SHOULD BE AN OPEN DRAIN AT THE SCOUR VALVE LOCATIONS TO LEAD THE WASHOUT WATER TO A SUITABLE WATER COURSE. 4. 6 MONTHS AFTER THE PIPE SYSTEM IS INSTALLED, INSPECT THE PIPELINE AT SEVERAL DIFFERENT

2. TURN ON THE PUMP TO BEGIN FLUSHING THE SYSTEM. RETAIN A MINIMUM OPERATING PRESSURE IN

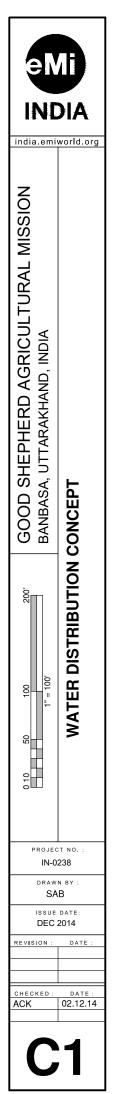

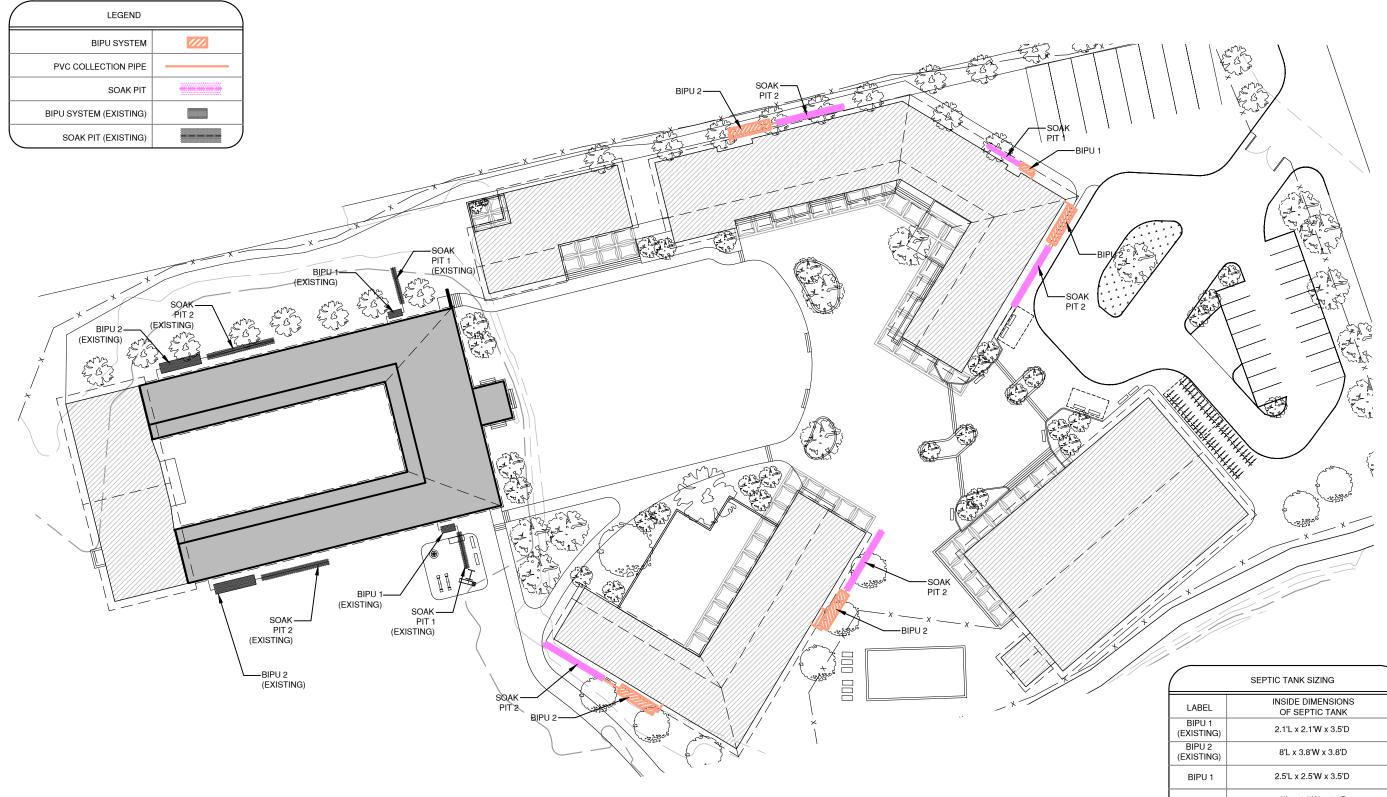





	SEPTIC TANK SIZING	
LABEL	INSIDE DIMENSIONS OF SEPTIC TANK	
BIPU 1 (EXISTING)	2.1'L x 2.1'W x 3.5'D	
BIPU 2 (EXISTING)	8'L x 3.8'W x 3.8'D	
BIPU 1	2.5'L x 2.5'W x 3.5'D	
BIPU 2	8'L x 4.0'W x 4.0'D	

	NEW SOAK TRENCH SIZING	
LABEL	DIMENSION	QUANTITY
SOAK PIT 1	19.5'L x 2.5'W x 3.5'D	1
SOAK PIT 2	36'L x 3.5'W x 5'D	4

NOTES:

1. FOR MORE INFORMATION ON THE INSTALLATION OF THE SEPTIC TANKS AND SOAK PITS, REFER TO THE REPORT.

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2	DATE : 02.12.14	DATE :	B date:			<b>)IA</b> world.org	